



### SCOPE OF WORK

770.00 SQ.FT.ADDITION TO PROVIDE NEW BEDROOM, TWO BATHROOMS, DEN & LAUNDRY, TO ENLARGE EXISTING MASTER BEDROOM AND MASTER BATHROOM. NEW WALK IN CLOSET. TO ADD AN ENTRY AREA WITH A SKYLIGHT. TO REMOVE EXISTING WOODEN FIREPLACE.
KITCHEN REMODELING. TO RELOCATE GARAGE DOOR. TO RELOCATE A DRIVEWAY.
TO ENLARGE EXISTING ROOF ABOVE THE REAR COVERED PATIO.

### PROJECT DATA

PATEL RESIDENCY 106 CHALLENGE Ct, Foster City, CA 94404 094042230 ONE STORY ADDITION AND REMODELING PUSHPA PATEL 650 773 8102 PROJECT NAME: PROJECT ADDRESS:

OWNER EMAIL: pdmenat@gmail.com

NATALIA AMATUNI 408 4200411 6925 RODLING DR. UNIT F, SAN JOSE, CA, 95138

### ZONNING: R-1

PROJECT SUMMARY

MIN. SETBACK FRONT: 20' MIN. SETBACK SIDE: 5' MIN. REAR SETBACK: 20' MAX. HEIGHT: 25' MAX. COVERAGE: 50%

TYPE OF CONSTRUCTION: VB OCCUPANCY: R-3

LOT AREA: 8.712 SQ.FT.

EXISTING HOUSE (CONDITIONED) AREA: 1,784.00 sq.ft.

GARAGE: 450.00 SQ.FT.

TOTAL EXISTING GROSS FLOOR AREA (WITH GARAGE): 2234.00 SQ FT

ADDITION: 770.00 SQ.FT.

PROPOSED HOUSE (CONDITIONED): 2554.00 SQ.FT.

EXISTING BLDNG HEIGHTS: 12'-1" PROPOSED BLDNG HEIGHTS: 12'-1"

TOTAL PROPOSED GROSS FLOOR AREA (WITH GARAGE): 3004.00 SQ.FT.

EXISTING LOT COVERAGE: ( 2.234.00 + 344.00 REAR ROOF OVERHANG +166.00ATRIUM=2744 SQ FT. ): 8.712=31.5%

THERE IS NO FIRE- SPRINKLER SYSTEM CURRENTRY IN THE HOUSE. COMBINATION OF NEW AND REMODEL WORK IS NOT EXCEEDS 50% OF THE ORIGINAL SQ.FT. OF THE HOME.

PROPOSED LOT COVERAGÉ: (2,983.00 + 336.00 REAR ROOF OVERHANG +71.00 PORCH + 166.00ATRIUM= 3556 SQ FT ): 8 712 =40,8%- COMPLY

EXISTING AVERAGE BUILDING HEIGHTS: 9'-8" PROPOSED BUILDING HEIGHTS: 10'-6" (SEE A.5 FOR CALCS.)

2022 CALIFORNIA CODE OF REGULATIONS AS AMENDED BY STATEOF CALIFORNIA AND ALL APPLICABLE CITY OF FOSTER CITY ORDINANCES WILL BE EMPLOYED DURING THIS PROJECT.

PLANS SHALL BE IN COMPLIANCE WITH:

CALIFORNIA BUILDING CODE. 2022 EDITION

CALIFORNIA RESIDENTIAL CODE, 2022 EDITION

CALIFORNIA PLUMBING CODE, 2022 EDITION

CALIFORNIA MECHANICAL CODE, 2022 EDITION

CALIFORNIA ELECTRICAL CODE, 2022 EDITION

2022 CALIFORNIA ENERGY CODE

2022 GREEN BUILDING CODE

2022 CALIFORNIA FIRE CODE

### CITY OF FOSTER CITY MUNICIPAL CODE

All building material, construction equipment, excavation material and debris must be maintained in a safe and sanitary, condition. Unless waived by the Building Official, such material shall be located behind the required front yard setback requirements when lacing waiterways.

Prior to or after commencement of construction, the Building Official may require a protective barrier such as a fence, barricade or other structure for the protection of the public around and in conjunction with any construction work. The design, construction, location, and materials used shall be approved by the Building Official prior to installation. The barrier shall be removed before receiving a Certificate of Occupancy.

# SUBJECT PROPERTY VICINITY MAP N.T.S (BK )4f PROJECT SUMMARY TABLE

lagoon)		
NET LOT AREA: (Only include land area, not portion in	8,712.0 square feet	

FLOOR AREA 1st FLOOR:	1784.0 <sub>square feet</sub>	2554.0 <sub>square feet</sub>
GARAGE:	450.0 square feet	450.0 square feet
TOTAL FLOOR AREA:	2234.0 <sub>square feet</sub>	3004.0 <sub>square feet</sub>
LOT COVERAGE: Include all land area covered by all structures (ex. sheds, patio covers), including all projections (covered entryways) except eaves, divided by the net loc area	2744. Oquare feet 81.59 SEE A2	3.556. Osquare feet 4.0.8%
HERGHT: Average height of sloped roof measured from the top of the ridge to the lowest point of the sloped roof. If there are multiple ridges, calculate werage of the two highest – see sample attached.	13feet4Inches	13_feet4inches
C		

SETBACKS:		
FRONT GARAGE	20 feet 0 inches	20 feet 0 inches
Front 1 <sup>st</sup> story	44feet0inches	
Front 2 <sup>nd</sup> story	feetinches	feetinches
Rear 1 <sup>st</sup> story	_44_feet _9_inches	38_feet8_inches
Rear 2 <sup>nd</sup> story	feetinches	feetinches
Right side 1 <sup>st</sup> story	9_feet _1_inches	5_feet0_inches
Right side 2 <sup>nd</sup> story	feetinches	feetinches
Left side 1 <sup>st</sup> story	7_feet _1_inches	7_feet1_inches
Left Side 2 <sup>nd</sup> Story	feetinches	feetinches
SPECIFIC EXTERIOR COLORS AND	EXISTING	PROPOSED

Left Side 2 <sup></sup> Story	ieetinches	iertintres		
SPECIFIC EXTERIOR COLORS AND MATERIALS:	EXISTING	PROPOSED		
Siding	THIN LINE EICHLER SIDING (BOARD AND BATTEN) COLOR SEIGE	THIN UNE EICHLER SIDING BY Breckerridge (BOARD AND BATTEN)		
Trim	WHITE WOOD	BROWN WOOD		
Roof	POLUYRETHANE FOAM ROOF CLASS "A"	POLUTRETHANE FOAM ROOF CLASS "A"		

NOTES:
CONTRACTOR OR OWNER/BUILDER IS RESPONSIBLE FOR VERIFICATION OF ALL SETBACKS,
DIMENSIONS AND ROOF SLOPES IN FIELD.

EXISTING LANDSCAPING TO BE PROTECTED DURING CONSTRUCTION AND TO BE RETAINED AFTER CONSTRUCTION.

FINISH GRADE AROUND THE STRUCTURE SHALL SLOPE AWAY FROM THE FOUNDATION A MIN. OF 5% FOR A MIN. DISTANCE OF 10 FEET

NOTE 1:2022 CALIFORNIA CODE OF REGULATIONS AS AMENDED BY STATE OF CALIFORNIA AND ALL APPLICABLE CITY OF CITY OF FOSTER CITY ORDINANCES WILL BE EMPLOYED DURING THIS PROJECT.

NOTE 2: CONTRACTOR / PROPERTY OWNER SHALL POST HOURS OF OPERATION AND PHONE NUMBERS FOR NOISE COMPLAINTS.

NOTE 3: ALL ACTIVITIES SHALL BE SUBJECT TO THE REQUIREMENTS OF THE CITY OF FOSTER CITY NOISE NOTE 4: NO DEBRIS BOXES OR BUILDING MATERIALS SHALL BE STORED ON THE STREET.

NOTE 5: THERE WILL BE NO NEW LANDSCAPED AREA AS THE PART OF THIS PROJECT. NOTE 6:PROVIDE TREE PROTECTION DURING CONSTRUCTION

NOTE 7: VERIFY LOCATION OF UNDERGROUND LITILITIES AND NOTIFY UTILITY COMPANY PRIOR TO DIGGING.

NOTE 8: IMPLEMENT REQUIRED MEASURES TO MINIMIZE STORM WATERRUN OFF FROM THE SITE AND PREVENT STORM WATER CONTAMINATION DURING CONSTRUCTION PROVIDE DRY WELLS UNDER EA DOWNSPOUT DISCHARGE.

NOTE 9: PLUMB INTERIOR FLOOR DRAINS TO SANITARY SEWER

NOTE 10: PLUMB INTERIOR GARAGE FLOOR DRAINS TO SANITARY SEWER

NOTE 11: MARK ON-SITE INLETS WITH THE WORDS "NO DUMPING! FLOWS TO BAY

NOTE 12: PROVIDE ROOFED AND ENCLOSED AREA FOR DUMPSTERS , RECYCLING CONTAINERS, ETC. TO PREVENT STORMWATER RUN ON AND RUNOFF.

NOTE 13: COVER STORED OUTDOOR EQUIPMENT/ MATERIALS TO AVOID POLLUTANT CONTACT WITH

NOTE 14: ROOF DRAINS SHALL DRAIN TO UNPAWED AREA WHEN PRACTICABLE. DRAIN BOILER DRAIN LINES, ROOF TOP EQUIPMENT, ALL WASHWATER TO SANITARY SEWER.

NOTE 15: DIRECT ROOF RUNOFF ONTO VEGETABLE AREA

NOTE 16: DIRECT RUNOFF FROM SIDEWALKS, WALKWAYS AND/ OR PATIOS ONTO VEGETABLE AREA

NOTE 17: NO METAL PIPING OR OTHERWISE SHALL BE IN DIRECT CONTACT WITH EARTH.

NOTE 18: DESIGN FOR DISCHARGE OF FIRE SPRINKLER TEST WATER TO LANDSCAPE OR SANITARY SEWER. ANY CONNECTION TO SANITARY SEWER SYSTEM IS SUBJECT TO SANITARY DISTRICT APPROVAL

Construction Hours: Assuming project approval, conditions of approval related to construction hours which are more limited than general citywide construction hours, will be added. PROJECT FOR 106 CHALLENGE FOSTER CITY, C A.

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REVISIONS

BY

NATALIA AMATUNI RESIDENTIAL DESIGN n.amatuni@gmail.com 408 4200411

PROJECT NO.

DATE

SHEET NUMBER

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OF

Per California Civil Code article 1101.4 and calgreen sec 301.1 Replace existing all non-conforming plumbing fixtures with water conserving plumbing fixtures. Non-compliant plumbing fixtures man any of the following:

Any tolet manufactured to use the following:
Any tolet manufactured to use the following:
Any tolet manufactured to the following:
Any allowed flow rate for propered with MAL. Klow rate of 126 GPF.
Any Bathroom's showerheads (single and multiple heads) maximum-allowed flow rate is 1.8 gpm, per 2016/2019 GGBC sec. 4303.13, att. 7111/A.
Any interior faucet that emiss more than 2.2 gallons of water per minute will need to be replaced with a faucet with 1.2 GPM@ 60 palk (V of 1.5 GMP)

60 pal for Michen faucets.) Only applied for properties in or before January  $\otimes$ 108 CHALLENGE CT ONE- STORY COURT HOUSE PILGRIM GARAGE CHALLENGE , 50' -R GARAGE 680 PILGRIM DRIVE 106 CHALLENGE CT ONE- STORY ONE- STORY 8068 4 HOUSE 684 PILGRIM DRIVE ONE- STORY HOUSE GARAGE 104 CHALLENGE CT ONE- STORY HOUSE ADJACENT PROPERTIES CONTEX 1"-20'

### DRAWING INDEX

FOSTER CITY

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8/15/2023

PLANNING/

CODE ENFORCEMENT

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	DRIVEWAY STUDY 2
	SURVEY
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S3	ROOF & CEILING FRAMING PLAN
83.1	ROOF/ CLNG DETAILS

### Storm water drainage and retention during construction:

1. Provide 5% min. slope away from the building (6" for the first 10 feet.) bullong (e for the first 10 feet.)


2. Cut swales at 1% slope min. to carry surface water to front yard landscaping. Refer to site plan to direction of drainage at swales.

3. Swale elevation of high point to be 0.10' min. below pad elevation.

 In no case shall the swale flowline be lower than the bottom of the footing within 5' of the footing.

5. To prevent soil erosion during construction

5. To prevent soil erossion during construction cover loose dirt with rolled account blankets or permeable geotextile fabric. Refer to manufacturer recommended overlapping and stappling methods. If necessary place straw wattles at the street property line to retain soil runoff on the site.

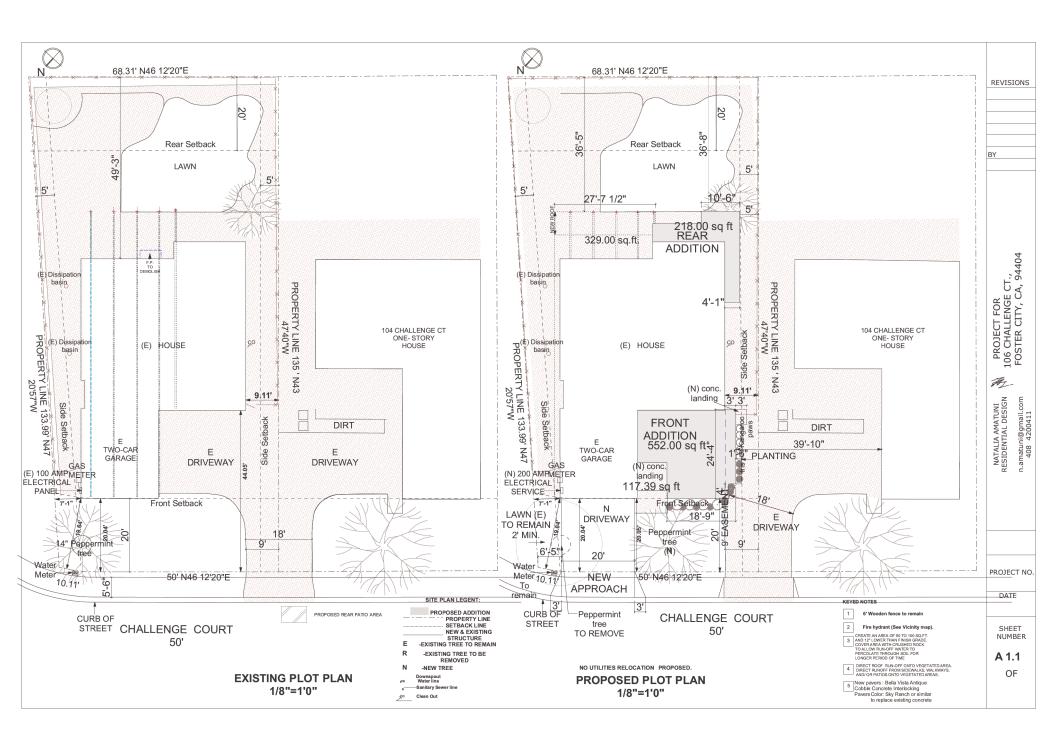

### **BEST MANAGEMENT PRACTICES** FOR CONSTRUCTION INDUSTRY

General Construction And



Site Supervision

### Best Management Practices for the Construction Industry

## Storm Drain Pollution Prevention: It's Up to Us

In San Mateo County, storm drains flow directly to local creeks, San Francisco Bay, and the Pacific Ocean with no treatment. Stormwater pollution is a serious problem for wildlife dependent on our waterways and for the people who live near polluted streams or wellands. Some common sources of this pollution in leads espilled oil, flut, common sources of this pollution include spilled oil, fue and fluids from vehicles and heavy equipment, landscape runoff containing pesticides or weed killers; and materials such as used motor oil, antifreeze, and paint products that people pour or spill into a street or storm drain.

All of the cities in San Mateo County have joined together with San Mateo County and the City/County Association of Governments (C/CAG) to educate local residents and businesses and fight storm drain pollution We hope you will join us, by using the practices in this pamphlet.

Storm Drain Pollution from Construction Activities Construction sites are common sources of storm drain pollution. Materials and wastes that blow or wash into a

- Clean up leaks, drips and other spills immediately so they do not contaminate soil or groundwater or leave residue on paved surfaces. Use dry cleanup methods whenever possible. If you must use water, use just enough to keep the dust down. Cover and maintain dumpsters. Check frequently for leaks. Place dumpsters under roofs or cover with

San Mateo Countywide Stormwater Pollution Prevention Program (STOPPP)

555 County Center Redwood City, CA 94063



### Requirements for Architectural Copper

Protect water quality during installation, cleaning, treating, and washing!

### Copper from Buildings May Harm Aquatic Life

Copper from Buildings May Harm Aquatic Life Copper can harm squadel file in Sar Inradicos Bay. Water that comes into contact with architectural copper may contribute to impacts into contact with architectural copper may contribute to impacts solutions that are used to obtain the deletined shade of green or brown typically contain acids. After treatment, when the copper is rinsed to remove these acids, the rinse water is a source of pollutaris. Municipalities prohibit discharges to the atom crim of water used in the installation, clienting and water file and the copper.



### Use Best Management Practices (BMPs)

The following Best Management Practices (BMPs) must be implemented to prevent prohibited discharges to storm drains.

### During Installation

- If possible, purchase copper materials that have been pre-patinated at the factory.
- . If patination is done on-site, implement one or more of the following BMPs:
- Discharge the rinse water to landscaping. Ensure that the rinse water does not flow to the street or storm drain.

  Block off storm drain inlet if needed.
- Collect rinse water in a tank and pump to the sanitary sewer. Contact your local sanitary sewer agency before discharging to the sanitary sewer.
- Collect the rinse water in a tank and haul off-site for proper disposal.





Block storm drain inlets as needed to prevent runoff from entering storm drains.

Discharge the wash water to landscaping or to the sanitary sewer (with permission from the local sanitary sewer agency). If this is not an option, haul the wash water off-site for proper disposal.

### Protect the Bay/Ocean and yourself!

Protect the Bayl/Ocean and yourself! If you are responsible for a discharge to the storm drain of non-stormwater generated by installing, cleaning, treating or washing copper architectural features, you are in violation of the municipal stormwater ordinance and may be subject to a fine.



e San Mateo Countywide Water I w.flowstobay.org (click on "Busin

## Water Pollution Prevention Program

## **Construction Best Management Practices (BMPs)**

Construction projects are required to implement the stormwater best management practices (BMP) on this page, as they apply to your project, all year long.



- ☐ Check waste disposal containers frequently for leaks and to make sure they are not overfilled. Never hose down a dumpster on the
- scens and spills.

  Dispose of all wates and debris properly. Recycle materials and wates that can be recycled (such as asphalt, concrete, aggregate base materials, wood, gay boant, pipe, etc.)

  Dispose of liquid ensidues from quirts, thinners, solvents, glazes, and cleaning fluids as bacardons waste.

### Equipment Management & Spill Control



- Clean up spills or leaks immediately and dispose of cleanup materials properly.
- where fluids have spilled. bsorbent materials, cat

## Earthmoving



Storm drain polluters may be liable for fines of up to \$10,000 per day!

### Paving/Asphalt Work Concrete, Grout & Mortan



### Painting & Paint Removal
























DRIVEWAY:402.73 sq ft

B ENTRY PORCH:171.32 sq ft 180.90 sq ft

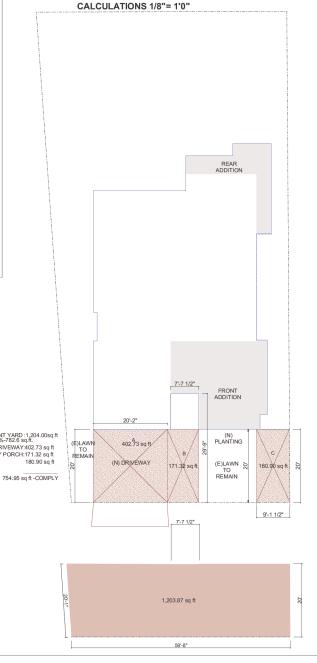

IMPERVIOUS AREA FRONT YARD

REVISIONS

BY

94404

PROJECT FOR 106 CHALLENGE CT., FOSTER CITY, CA, 9

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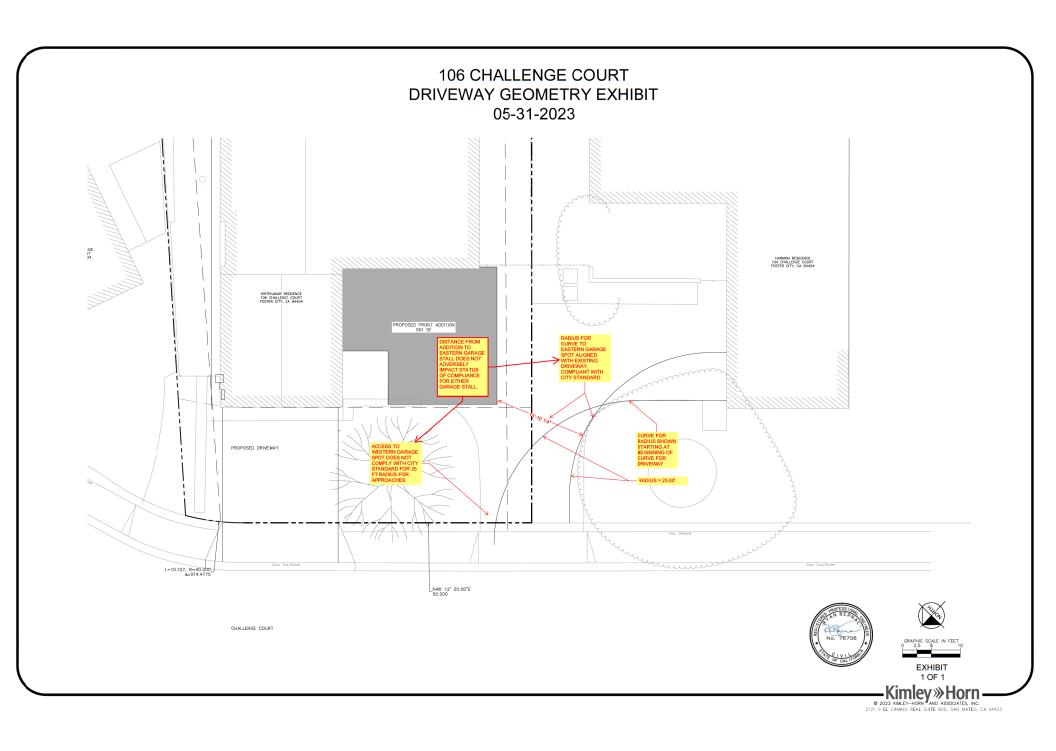
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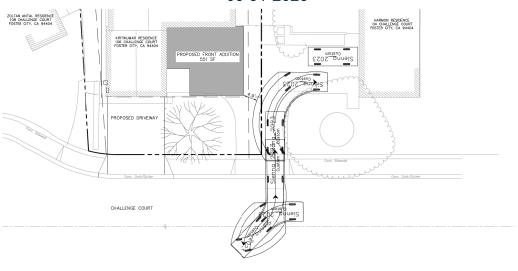
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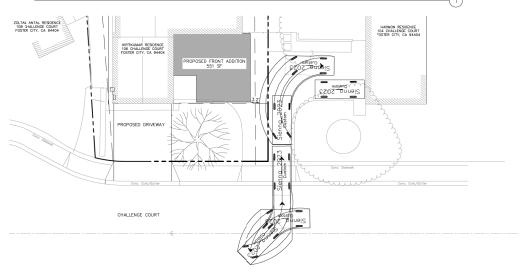
Toyota\_Sienna\_2023

feet

Width : 6.54 Track : 5.71 Lock to Lock Time : 6.0 Steering Angle : 24.0

VEHICLE DIMENSIONS

## REVERSE ENTRY TO WESTERN PARKING SPOT ON DRIVEWAY OR INTO GARAGE




REVERSE ENTRY TO EASTERN PARKING SPOT ON DRIVEWAY OR INTO GARAGE





EXHIBIT 1 OF 4

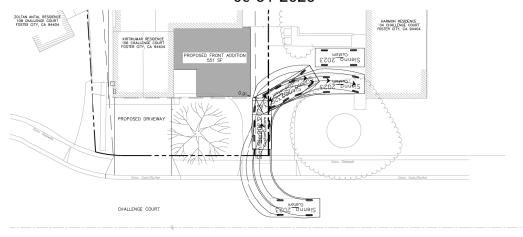




Toyota\_Sienna\_2023

Width : 6.54
Track : 5.71
Lock to Lock Time : 6.0
Steering Angle : 24.0

VEHICLE DIMENSIONS

## HEAD-IN ENTRY TO WESTERN PARKING SPOT ON DRIVEWAY OR INTO GARAGE

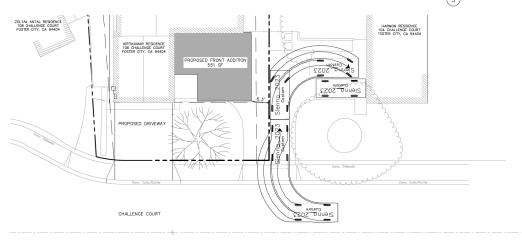






**EXHIBIT** 

2 OF 4

HEAD-IN ENTRY TO EASTERN PARKING SPOT ON DRIVEWAY OR INTO GARAGE

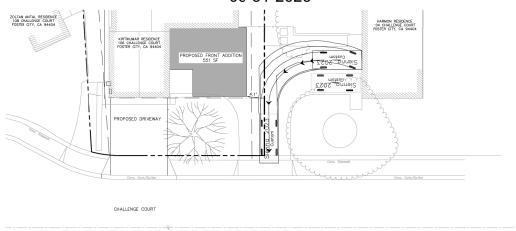




Toyota\_Sienna\_2023

feet

Width : 6.54
Track : 5.71
Lock to Lock Time : 6.0
Steering Angle : 24.0

VEHICLE DIMENSIONS

## REVERSE DEPARTURE FROM EASTERN PARKING SPOT ON DRIVEWAY OR FROM GARAGE

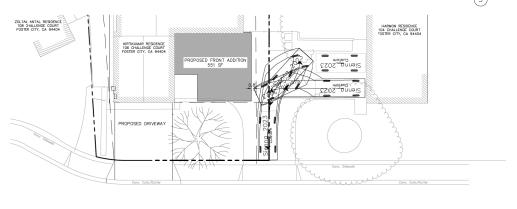


CHALLENGE COURT





REVERSE DEPARTURE FROM WESTERN PARKING SPOT ON DRIVEWAY OR FROM GARAGE

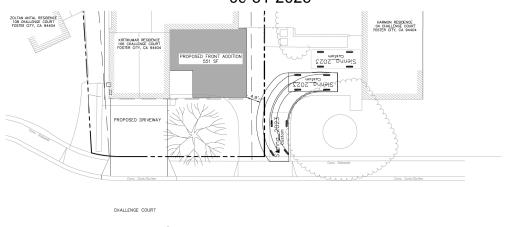




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Width : 6.54
Track : 5.71
Lock to Lock Time : 6.0
Steering Angle : 24.0

VEHICLE DIMENSIONS

## HEAD-OUT DEPARTURE FROM WESTERN PARKING SPOT ON DRIVEWAY OR FROM GARAGE




CHALLENGE COURT

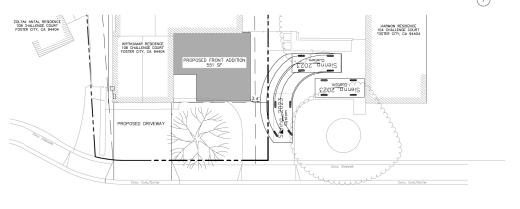




 $\underline{\mathsf{HEAD}}. \mathbf{OUT} \ \mathsf{DEPARTURE} \ \mathsf{FROM} \ \mathsf{EASTERN} \ \mathsf{PARKING} \ \mathsf{SPOT} \ \mathsf{ON} \ \mathsf{DRIVEWAY} \ \mathsf{OR} \ \mathsf{FROM} \ \mathsf{GARAGE}_{(8)}$ 

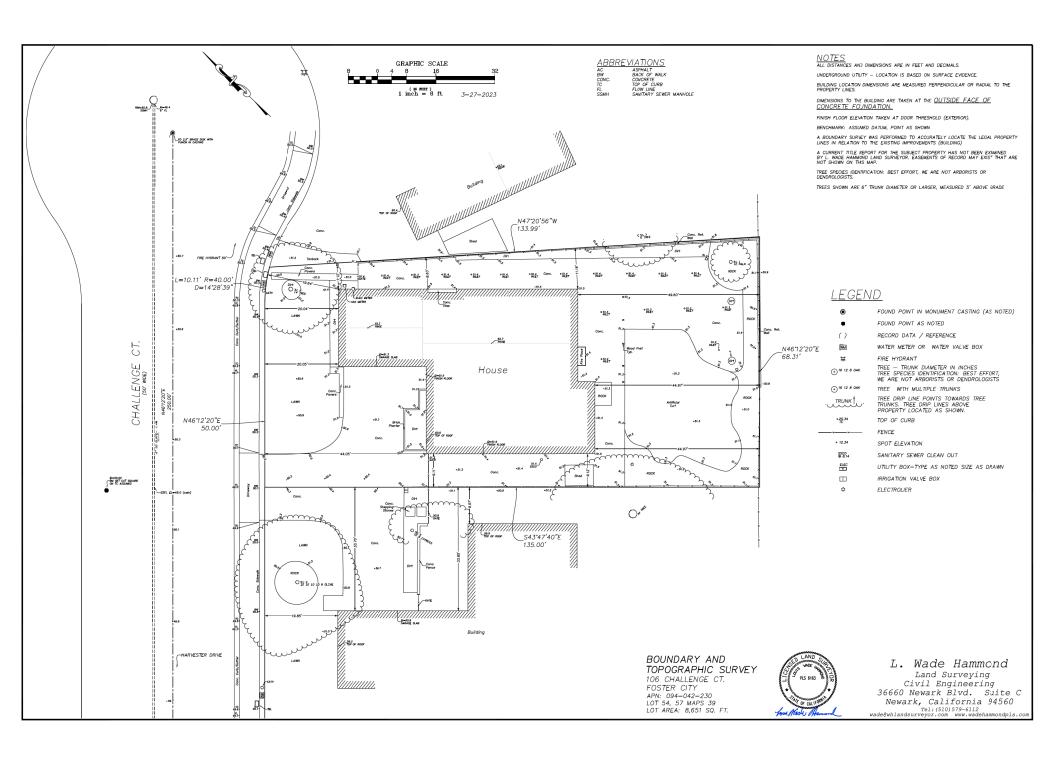



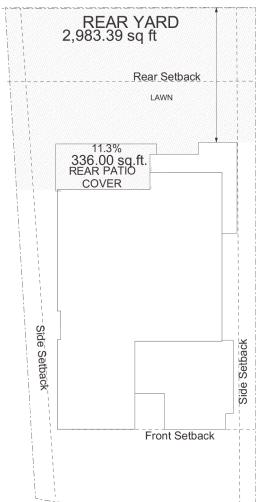

REAR PATIO COVER CALCULATIONS 1/8"= 1'0"

REAR PATIO ROOF CALCULATIONS: 329 SQ FT DIVIDED BY 2,983 SQ FT= 11%



FRONT



RIGHT



LEFT



3D MODELS



REVISIONS


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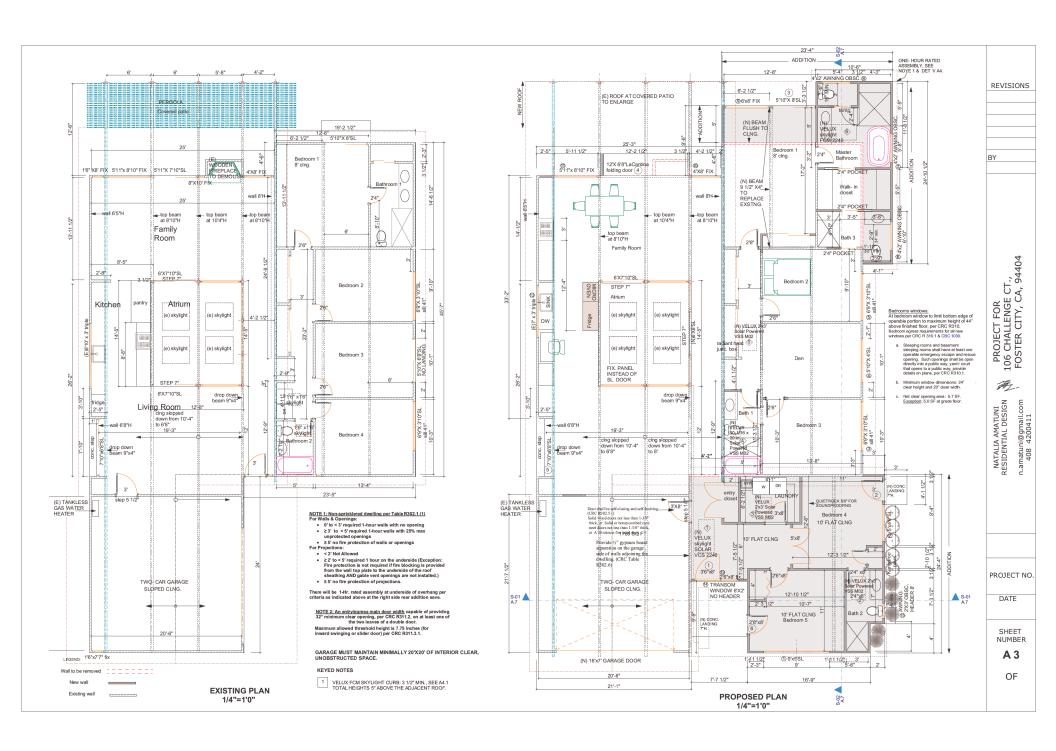
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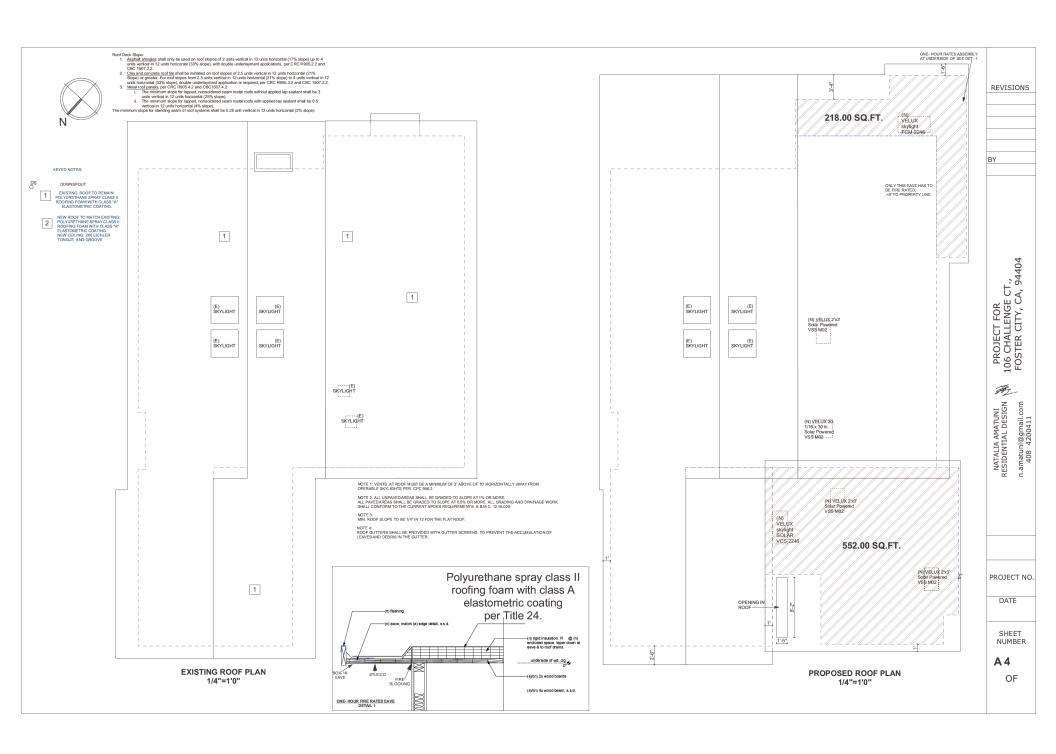
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**A 1.3** OF







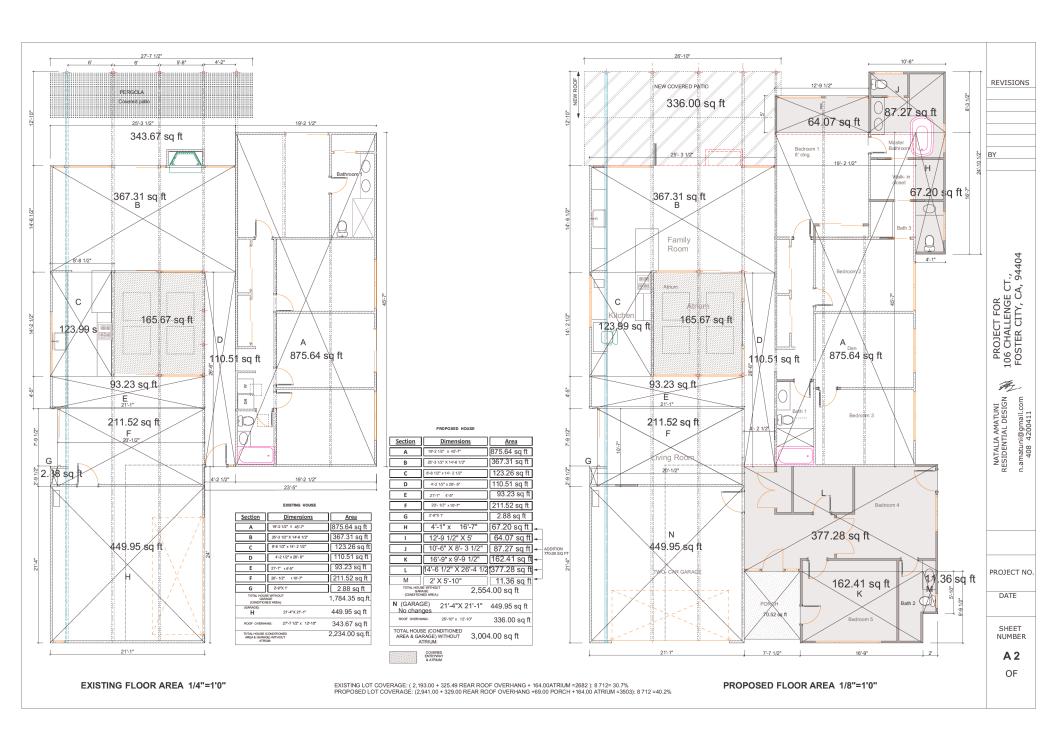

CITY OF FOSTER CITY

A. Project Information	. Project Information						
A.1 Project Name:	Patel residence addition and remodeling						
A.2 Project Address:	106 Challenge Ct., Foster City, Ca						
A.3 Project APN:	094042230	Ī					

- B.1 Does the project create and/or replace 2,500 square feet or more of impervious surface<sup>2</sup>?
  - If yes, and the project received final discretionary approval on or after December 1, 2012, the project must include at least one of the Site Design Measures stated below in section a through If Fact sheets regarding site design measures a through If may be downloaded at your (Insuration confinedate) comparities;
  - If no, or the project received find discretionary approval before December 1, 2012, the project applicant shall be encouraged to implement appropriate also design measures' from the list below, which may be required at municipalit discretion. Constitution that the state of the project.

### ne list below, indicate whether each site design measure is included in the project plans and the plan

Yes	No	Plan Sheet No.
	⊠	<ul> <li>Direct roof runoff into disterns or rain barrels and use rainwater for intigation or other non-potable use.</li> </ul>
⊠		A1 b. Direct roof runoff onto vegetated areas.
	⊠	<ul> <li>Direct runoff from sidewalks, walkways, and/or patios onto vegetated areas.</li> </ul>
	⊠	<ul> <li>Direct runoff from driveways and/or uncovered parking lots onto vegetated areas.</li> </ul>
	⊠	e. Construct sidewalks, walkways, and/or patios with permeable surfaces.
	Ø	<ol> <li>Construct bike lanes, driveways, and/or uncovered parking lots with permeable surfaces.</li> </ol>
	⊠	g. Minimize land disturbance and impervious surface (especially parking lots).
	Ø	<ul> <li>Maximize permeability by clustering development and preserving open space.</li> </ul>
	図	<ol> <li>Use micro-detention, including distributed landscape-based detention.</li> </ol>
	Ø	<ul> <li>Protect sensitive areas, including wetland and riparian areas, and minimize changes to the natural topography.</li> </ul>
	⊠	k. Self-treating area (see Section 4.2 of the C.3 Technical Guidance)
	図	Self-retaining area (see Section 4.3 of the C.3 Technical Guidance)
	四	m. Plant or preserve interceptor trees (Section 4.1, C.3 Technical Guidance)

Are these features in project?  Yes No		require source Source control measures control (Refer to Local Source Control List for detailed requirements)		Is source control measure included in project plans?			
				Yes	No	Plan Sheet No	
	×	Storm Drain	Mark on-site inlets with the words "No Dumping! Flows to Bay" or equivalent.			A1	
	<b>8</b>	Floor Drains	Plumb interior floor drains to sanitary sewer [or prohibit].	×		A1	
	K	Parking garage	<ul> <li>Plumb interior parking garage floor drains to sanitary sewer.<sup>6</sup></li> </ul>	×		A1	
K		Landscaping	Retain existing vegetation as practicable.     Select diverse species appropriate to site. Include plants that are pest-and/or cleave-resistant, drought-tolerant, and/or attract beneficial insects.     Minimize use of pesticides and quick-release fertilizers.     Use efficient imigation system, design to minimize runoff.		⊠		
	⊠	Pool/Spa/Fountain	<ul> <li>Provide connection to the sanitary sewer to facilitate draining.<sup>6</sup></li> </ul>		$\boxtimes$		
	×	Food Service Equipment (non- residential)	Provide sink or other area for equipment cleaning, which is:  Connected to a greeze interceptor prior to sanitary sever discharge.  Large enough for the largest mat or piece of equipment to be cleaned.  Indoors or in an outdoor notified area designed to prevent stormwater run-on and run-off, and signed to require equipment washing in this area.		⊠		
	80	Refuse Areas	<ul> <li>Provide a roofed and enclosed area for dumpsters, recycling containers, etc., designed to prevent stormwater run-on and runoff.</li> <li>Connect any drains in or beneath dumpsters, compactors, and tallow bin areas sensing food service facilities to the sarritary sewer.</li> </ul>	⊠		A1	
	Ø	Outdoor Process Activities	<ul> <li>Perform process activities either indoors or in roofed outdoor area, designed to prevent stormwater run-on and runoff, and to drain to the sanitary sewer.</li> </ul>		×		
Ø		Outdoor Equipment/ Materials Storage	Cover the area or design to avoid pollutant contact with stomwater runoff.  Locate area only on paved and contained areas.  Roof storage areas that will contain non-hazardous liquids, drain to sanitary sewer, and contain by berms or similar.			A1	
	M	Vehicle/ Equipment Cleaning	<ul> <li>Roofed, pave and berm wash area to prevent stomwater run-on and runoff, plumb to the sanitary sewer, and sign as a designated wash area.</li> <li>Commercial car wash facilities shalf discharge to the sanitary sewer.</li> </ul>		×		
	Ø	Vehicle/ Equipment Repair and Maintenance	Designate repair/maintenance area indoors, or an outdoors area designed to prevent stormwater nun-on and runoff and provide secondary containment. Do not install daries in the secondary containment areas.  No floor drains unless pretreated prior to discharge to the sanitary sewer. 6.  Connect containers or sirks used for past cleaning to the sanitary sewer. 6.				
	Ø	Fuel Dispensing Areas	Fueling areas shall have impermeable surface that is a) minimally graded to prevent ponding and b) separated from the rest of the site by a grade break.     Canopy shall extend at least 10 ft. in each direction from each pump and drain away from fueling area.		×		
	×	Loading Docks	Cover and/or grade to minimize sun-on to and runoff from the loading area.     Position downspouts to direct stormwater away from the loading area.     Drain water from loading dock areas to the sanitary sewer.     Install door skirts between the trailers and the building.		⊠		
	⊠	Fire Sprinklers	Design for discharge of fire sprinkler test water to landscape or sanitary sewer <sup>6</sup>	⊠		A1	
⊠		Miscellaneous Drain or Wash Water	Drain condensate of air conditioning units to landscaping. Large air conditioning units may connect to the sanitary sewer.*     Roof drains shall drain to unpared area where practicable.     Drain boiler drain lines, roof top equipment, all washwater to sanitary sewer.*	×		A1	
	×	Architectural Copper	<ul> <li>Drain rinse water to landscaping, discharge to sanitary sewer<sup>6</sup>, or collect and dispose properly offsite. See flyer "Requirements for Architectural Copper."</li> </ul>	Ø			

STORMWATER CHECKLIST

1/1/16 v.2

### Stormwater Checklist for Small Projects

Implementar Construction best issuingement infections (select) proquered for all projects).

It is the site of high Priority Stars? (Allerjace) lateful will make the determination; if the answer is yee, the project will be referred to construction also image-alons staff for morely accommissive respections are "failused projections." (Allerjace) and the project of the determination of the project of the determination of the size of the project of the determination of the determination of the project of the determination of the project of the determination of the project of the determination of the de

### D.2 All projects require appropriate stormwater BMPs during construction - indicate which BMPs are included in the project, bel

## Yes No Best Management Practice (BMP) □ Attach the San Mateo Countywide Water Pollution Prevention Program's construction BM project plans and require contractor to implement the applicable BMPs on the plan sheet.

- ☑ Temporary erosion controls to stabilize all denuded areas until permanent erosion controls are established. Delineate with field markers the following areas: clearing limits, easements, setbacks, sensitive or critical areas, buffer zones, trees to be protected and retained, and drainage courses.
- artes, Louise zones, tres productions, or statutiments describing to describe described. Provider notes, specifications, or statutiments describing the described provider notes, specifications, or statutiments describing the described providers and schedule for gealing, secretarial sections, and storage and disposal of excessed on Cederal material.

   Specifications for repetation cover & much, include methods and schedules for planning and fertilization;
   Provisions for therepower pricing permanent insighton.
- Perform clearing and earth moving activities only during dry weather.

- Protect adjacent properties and undisturbed areas from construction impacts us sediment barriers or filters, dikes, mulching, or other measures as appropriate.
- □ Unit construction access routes and stabilize designated access points.
   □ No cleaning, fueling, or maintaining vehicles on-site, except in a designated area when contained and treated.
- Store, handle, and dispose of construction materials/wastes properly to prevent contact with stormwater
- ☐ Contractor shall train and provide instruction to all employees/subcontractors re: construction BMPs.
   ☐ Control and prevent the discharge of all polential publishers, including pawement cutting washes, paints, controls, perfordum products, chemicals, washeader or sediments, rinse water from architectural copper non-dommeter discharges to storm drains and watercourses.

F. 1	NOTES (for municipal staff use only):
	Section A Notes:
	Section R Notes:

1///6 / 2

Vapor bo Note 2

1.15.23



UNDER CONSTRUCTION AREA: 552 SQ.FT. + 492 SQ.FT.= 1,044.00 SQ.FT TOTAL EXISTING GROSS FLOOR AREA (WITH GARAGE): 2234.00 SQ FT

**CALCULATION FOR SPRINKLER RETROFIT** 1/8"=1'0"

ECL
Aspholt shingles
Light short ELEVATION 1/4" Max.-Underloyment Note 1 & 3 BASIS OF DESIGN: VELUX FOM ourb mounted fixed skylight A Julius Aspholt -

SECTION A-A Vapor ba Note 2 This drawing is an instrument of service and is provided for informational use only.

© 2010 VELIX GROUP

SEE DETAIL 1 #8 x 1%\* Stainless Steel Wood Screw By Others VELUX ECL Floshin (See COMPATIBLE FLASHINGS:, below From Heldel (Outside Outs) - Drywali By Other faximum Skylight Clearance Width Decking — By Others VERTICAL CROSS SECTION HORIZONTAL CROSS SECTION DETAIL (1) ### No. | 194 | 194 | 19 Laminated LowE3 (04) Tempered LowE3 (05) Impact (06) Mjami-Dade (07) White Laminated (08) COMPATIBLE FLASHINGS: VELUX 1418 Evans Pond Road Greenwood, SC 2669 1-800-88-VELUX WMR, VII 1017\* VELUX FCM - Fixed Curb Mounted Skylight

REVISIONS

FCM

BY

l., 94404

PROJECT FOR 106 CHALLENGE CT., FOSTER CITY, CA, 94

A. NATALIA AMATUNI RESIDENTIAL DESIGN n.amatuni@gmail.com 408 4200411

PROJECT NO.


DATE


SHEET NUMBER


A 4.1

OF

SKYLIGHT DETAILS

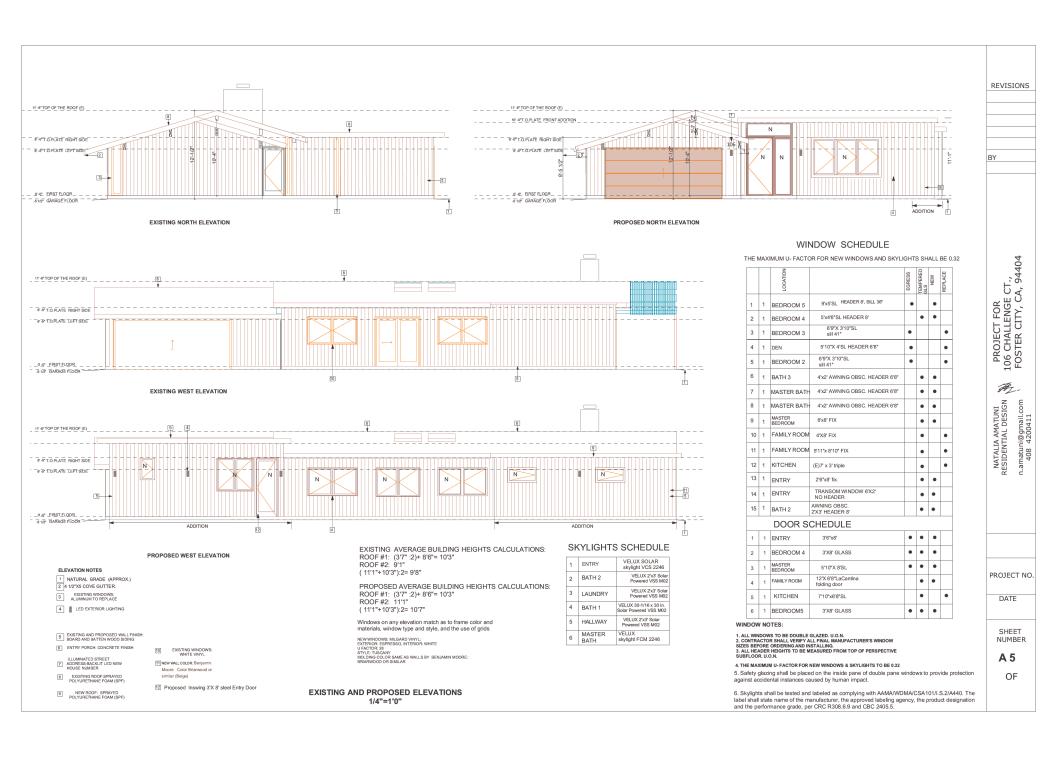

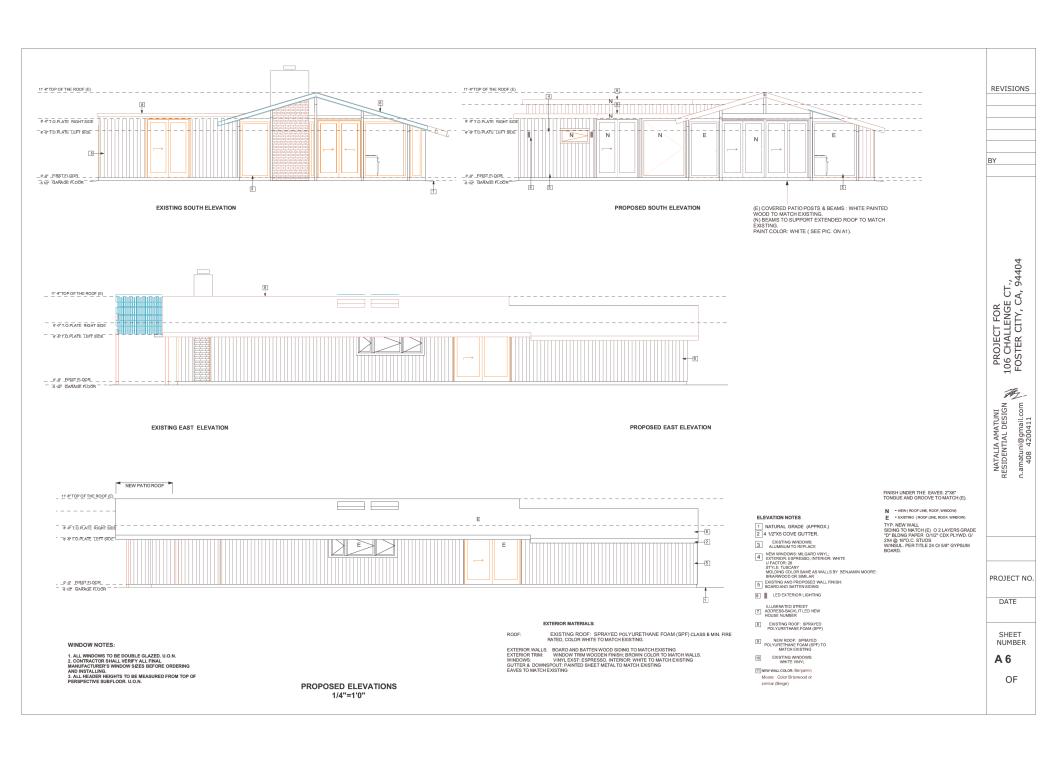

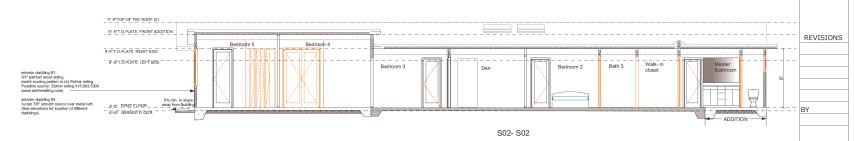

EXISTING SIZE (w X h)

7'x3' 7'x3' 20" 33"

n/a 2'6"x8' n/a

n/a 6'x2' n/a n/a

n/a 2'x3' 20"

uminum brown No Grids

Auminum brown No Grids

n/a

n/a

Picture

#12 Kitchen Slider w/Picture Slider w/Picture Aluminum


#13 Entry

#14 Entry

#15 Bath 2 11/8

CLEAR OPENING WIDTH

n/a

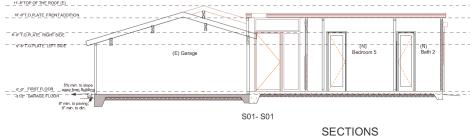

1/4"=1'0"

PROJECT FOR 106 CHALLENGE CT., FOSTER CITY, CA, 94404

A.

NATALIA AMATUNI RESIDENTIAL DESIGN n.amatuni@gmail.com 408 4200411

PROJECT NO.

DATE

SHEET NUMBER

Α7

OF


Building Permit#: AR2023-0004 City of Foster City Window/Patio Door Schedule Information

Property Address: 106 Challenge Ct. If property is located in an HOA, please list HOA.

	ROOM	EXISTING WINDOW TYPE (slider, single hung, etc.)	NEW WINDOW TYPE (slider, single hung, etc.)	EXISTING WINDOW MATERIAL AND COLOR	NEW WINDOW MATERIAL AND COLOR	GRIDS or NO GRIDS	EXISTING SIZE (w X h)	NEW SIZE (w X h)	CLEAR OPENING WIDTH	CLEAR OPENING HEIGHT
1	Bedroom 5	n/a	Slider w/Picture	n/a	Vinyl brown	No Grids	n/a	9'x5'	30"	4'6"
2	Bedroom 4	n/a	Slider	n/a	Vinyl brown	No Grids	n/a	5'x4'6"	30"	4'
3	Bedroom 3	Slider	Slider	Vinyl white	Vinyl brown	No Grids	6'9"x3'10"	6'9"x3'10"	36"	3'6"
4	Den	Slider	Slider	Vinyl white	Vinyl brown	No Grids	5'10"x4'	5'10"x4'	33"	3'6"
5	Bedroom 2	Slider	Slider	Vinyl white	Vinyl brown	No Grids	6'9"x3'10"	6'9"x3'10"	36"	3'6"
6	Bath 3	n/a	Awning	n/a	Vinyl brown	No Grids	n/a	4'x2'	42"	20"
7	Master bath	n/a	Awning	n/a	Vinyl brown	No Grids	n/a	4'x2'	42"	20"
8	Master bath	n/a	Awning	n/a	Vinyl brown	No Grids	n/a	4'x2'	42"	20"
9	Master bdrm	n/a	Picture	n/a	aluminum Brown	No Grids	n/a	6'x8'	n/a	n/a
10	Family room	n/a	Picture	n/a	aluminum brown	No Grids	n/a	4'x8'	n/a	n/a
		•		16.				6 20 20	122	

Date: 6.20.2023 Applicant or property owner signature: \_\_\_

\* USE ONE OR MORE OF THIS FORM IF YOU HAVE 11 OR MORE WINDOWS/PATIO DOORS.

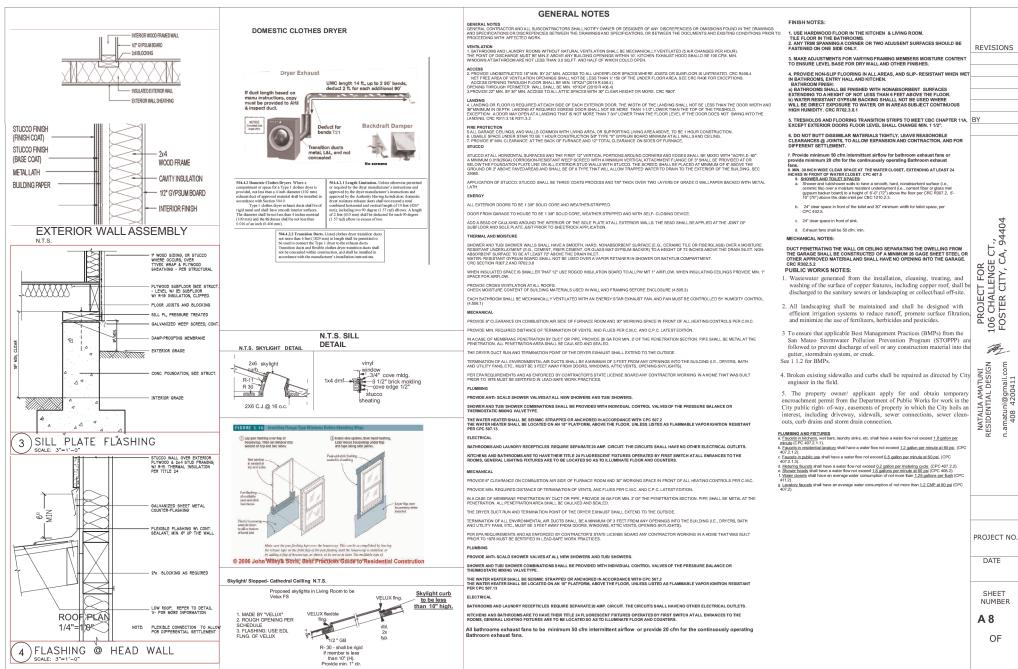

natuni@gmail.com 408 4200411